CHAS. ROBERTS AIR CONDITIONING, INC. 9828 N. 19th AVENUE PHOENIX, ARIZONA 85021 943-7291

DATE: 12-16-99

BUILDER: republic homes PLAN: 2102 SENSIBLE 39586 1840 LATENT TOTALS 41426 EQUIPMENT SELECTION UNITA - GOODMAN 5 TON SPLIT SYSTEM HEAT PUMP MODEL CPKE60-1/A61 44500 BTU/H COOLING RATED @ ARI CONDITIONS 51000 BTU/H HEATING FLA. 25.3/6.0 GAS/ELECTRIC

UNIT A — GOODMAN 5 TON GAS/ELECTRIC SPLIT AIR CONDITIONING SYSTEM MODEL CK60-1(OUTDOOR)/H-61(COIL)/GMPH120-5(GAS FURNACE) 56000 BTU/H COOLING RATED @ ARI CONDITIONS 100000 BTW/H HEATING FLA. 30.6/9.9EXHAUST FANS - EF-1 = AIRO 650 HOODS - ROUGH-IN EF-2 = AIRO 2510

DESIGN CONDITIONS

WINTER


REGISTERS - RRAC 800-50/150

SUMMER

R/A GRILLES — RRAC 50GH-5FF

OUTSIDE TEMPERATURE 34 DB OUTSIDE TEMPERATURE 110 DB - 71 WB INSIDE TEMPERATURE 74 DB INSIDE TEMPERATURE 78 DB - 63 WB

LOAD CALCULATED IN ACCORDANCE WITH AIR CONDITIONING CONTRACTORS OF AMERICAN MANUAL J 7TH EDITION

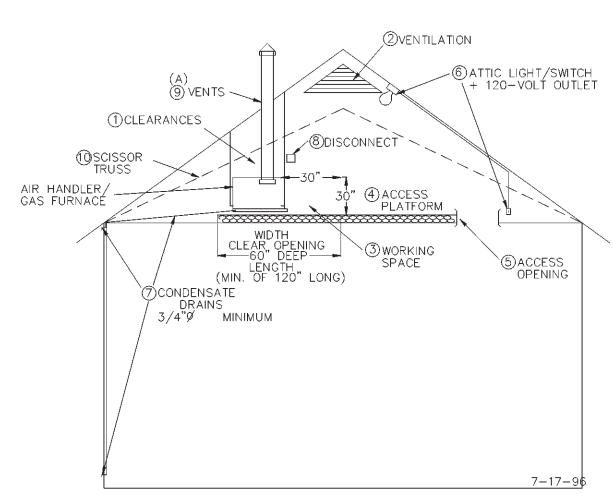

REQUIREMENTS FOR ATTIC AIR HANDLER OR GAS FURNACE

1. CLEARANCES FROM COMBUSTABLE MATERIALS FOR GAS FIRED FURNACES MUST BE AS SPECIFIED IN THE MANUFACTURER'S INSTALLATION INSTRUCTIONS AND APPLICABLE LOCAL BUILDING CODES. (A)

2. VENTILATION - THE NET Free VENTILATION AREA SHALL NOT BE LESS THAN 1/150 of the area

OF THE NET Free VENTILATION AREA SHALL NOT BE LESS THAN 1/150 of the gred
OF THE SPACE VENTILATED.

EXECPTIONS: THE AREA MAY BE 1/300 OF THE AREA OF THE SPACE VENTILATED PROVIDED 50

PERCENT OF THE REQUIRED VENTILATING AREA IS PROVIDED BY VENTILATORS

LOCATED IN THE UPPER PORTION OF THE SPACE VENTILATED AT LEAST 3 FEET

ABOVE EAVE OR CORNICE VENTS WITH THE BALANCE OF THE REQUIRED VENTILATION

PROVIDED BY EAVE OR CORNICE VENTS.

\* REQUIRED ATTIC VENTILATION EXCEEDS REQUIREMENTS FOR FURNACE COMBUSTION AIR. (A)

3. WORKING SPACE — A WORKING PLATFORM must NOT be LESS THAN 30 inches in depth fOR THE ENTIRE SERVICE SIDE OF THE FURNACE WITH A minimum height of

4. access platform — the access platform must be a minimum of 24 inches wide

continious floor not more than 20 feet in length unless the entire AIR HANDLER/furnace can be serviced from the attic access opening. \* make provisions for propér insulation to be installed under the platforms

5. access opening — attic openings and passageways to the AIR HANDLER/furnace must be 30 INCHES X 30 INCHES.

execption: the access opening into the space may be 22 inches by 30 inChes

provided the largest piece of equipment can be removed through this

6. attic light — a permanent 120—volt receptical outlet and lighting fixture controlled by a switch located at the required passage way opening shall be provideD at or near the AIR HANDLER/furnace.

7. condensate drains — a secondary drain pan must be installed under the coil section to prevent damage to the ceiling below, the secondary drain must be installed with a minimum grade of 1/8 inch per 12 inches of horizontal run and must exit to the outside where it can be readily visible.


8. disconnect — a positive means of electrical disconnect must be located at or near the AIR HANDLER/furnace.

9. vents— type b vent, size per furnace manufactures specifications. vents must terminate in accordance to u.m.c. requirements provided they are at least 8 feet from any vertical wall of 45 DEGREES or more and terminate not less that 2 feet higher than the highest point they pass through. (A)


(A) - APPLIES TO GAS FURNACE ONLY.

10. if furnace is located below scissor truss the recommend insulating proceedure is along ceiling LINE below the furnace not along scissor above to provide proper combustion AIR with out COMPROMISING the integrity of the thermal envelope by penetrating it with combustion ducts. (A) the specifications above meet the minimum requirements established in the 1988, 1991, 1994, 1997 u.b.c and u.m.c.

05-10-99

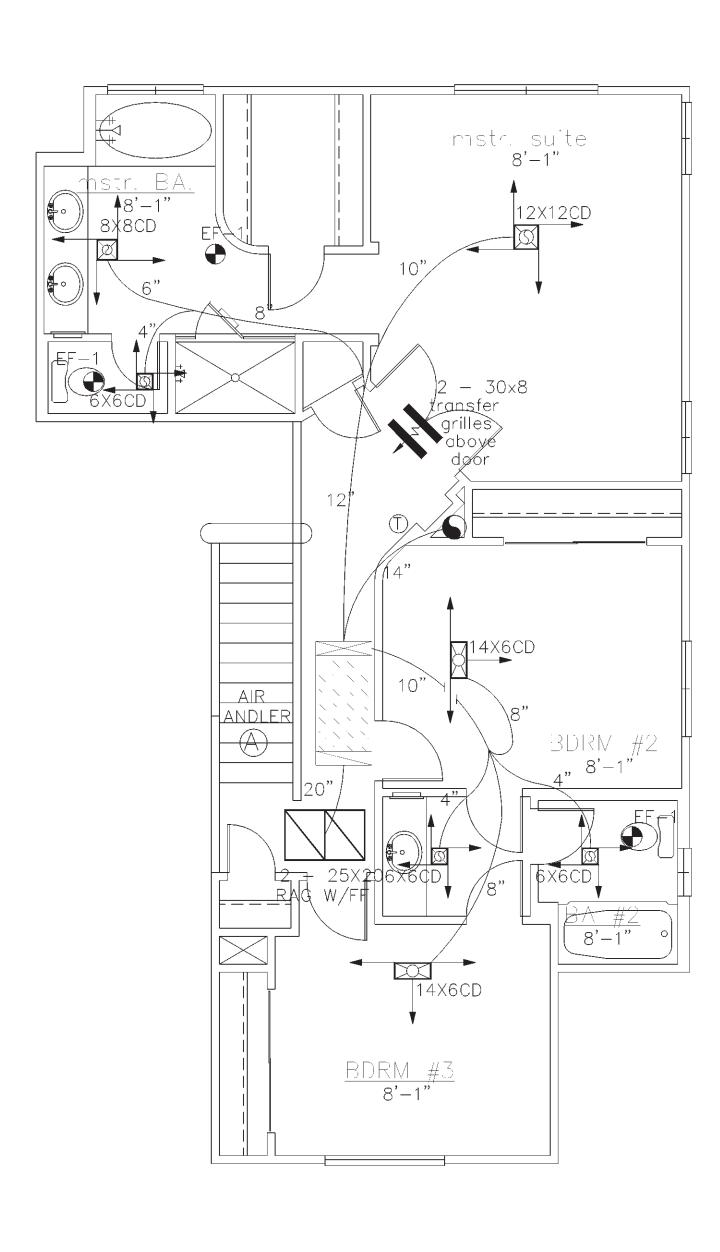

SECOND FLOOR MECHANICAL PLAN

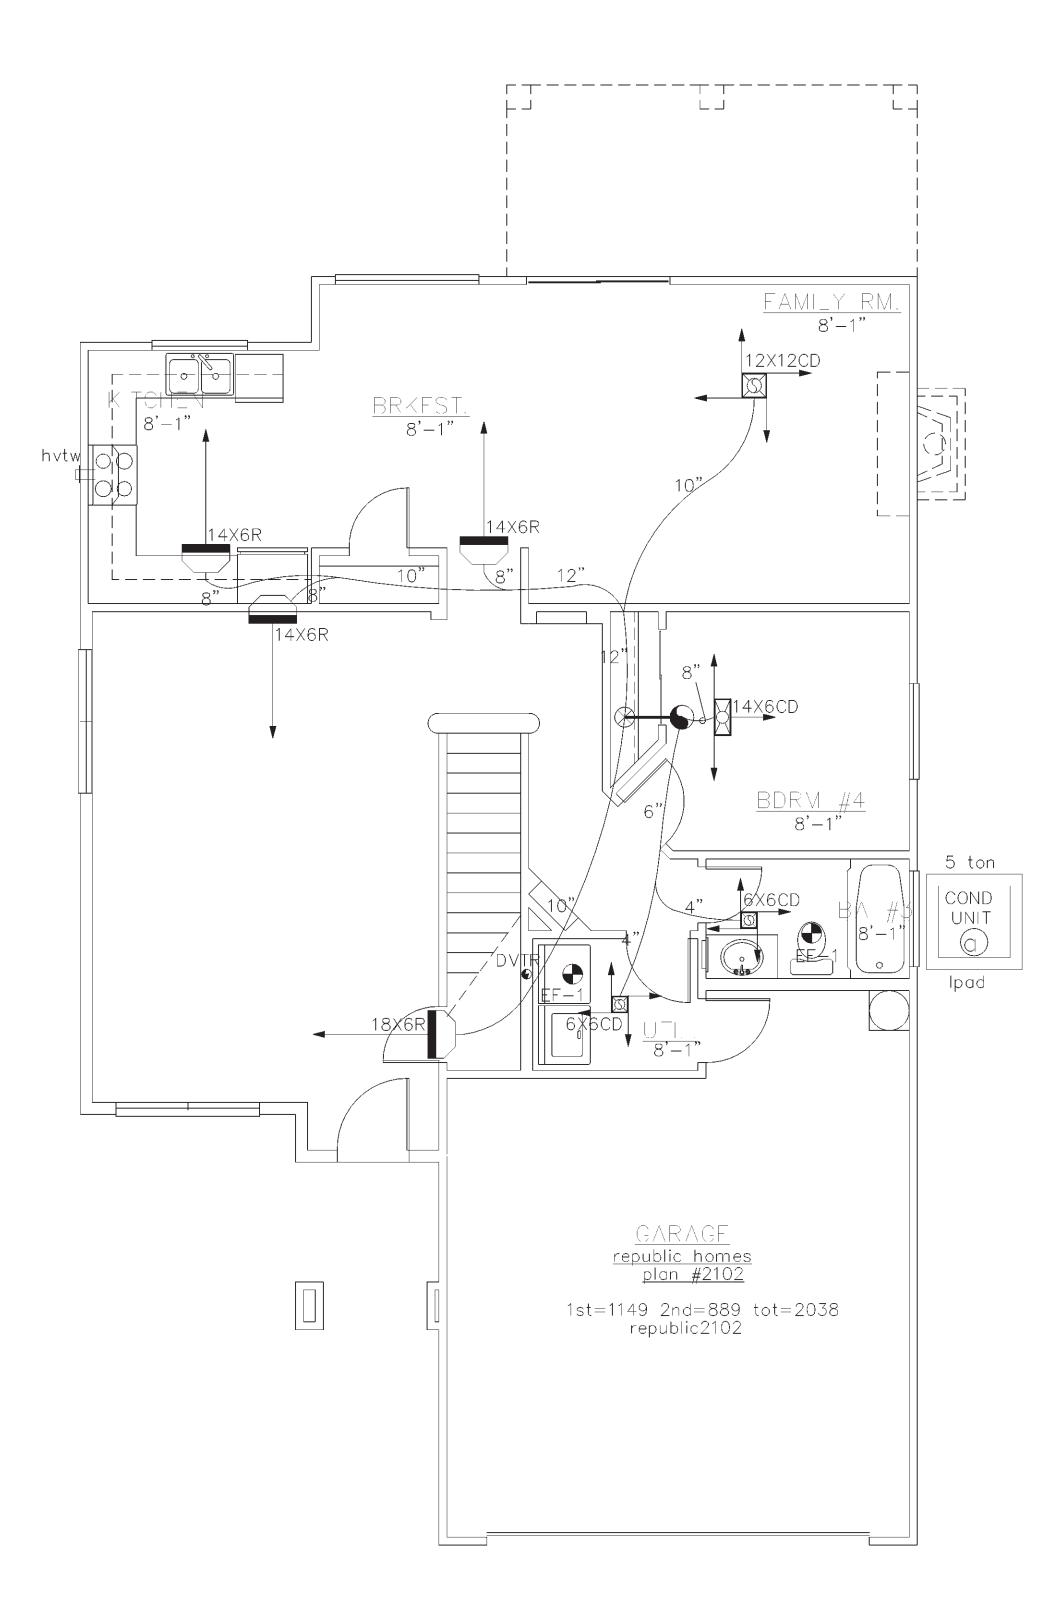

FIRST FLOOR MECHANICAL PLAN SCALE: 1/4" = 1'-0"

 $\triangleleft$  $\triangleleft$ PROJECT NO.: RH99-0504 DRAWN BY: S. PREUSS DATE: 16 SEP 99 REVISIONS